COLOUR SCHEME

SAMPLES	COLOUR	SURFACE
	Stamped Concrete	Driveway
	'Raku' by Dulux or Similar	 External walls rendered and painted (refer to 3D views and Elevations) Front fence elements
	'Timeless Grey' by Dulux or Similar	- External walls rendered and painted (refer to 3D views and Elevations)
	'Vivid White' by Dulux or Similar	External walls rendered and painted (refer to 3D views and Elevations) Front fence elements
	'Natural Copper' by Alucobond	- External walls (refer to 3D views and Elevations)
	Grey Marble Tiles	- Porch and Terrace
	Slimline 'Gunmetal' Texture by Boral	- Roofing (refer to 3D views and Elevations)

SHEET INDEX

Layout ID	Layout Name
.1	Cover Sheet
.2	Site Analysis
.3	Site Plan
.4	Ground Floor Plan
.5	BASEMENT PLAN
.6	First Floor Plan
.7	North & East Elevations
.8	South & West Elevations
.9	Building Sections AA & BB
.10	Landscape Concept Plan
.11	FSR Calculation / Driveway Sections D-D
.12	Doors and Windows List & Basix Requirements
.13	Shadow Diagrams - Winter Solstice
.14	Front Fence / Streetscape
.15	Pool Section / Elevations
.16	Demolition Plan/ Traffic Management Plan
.17	Sediment Control Plans
.18	3D Views



CONSTRUCTION OF A TWO STOREY HOUSE WITH BASEMENT

Note : Colour of proposed samples may change upon execution.

Basix and Nathers commitments are: -R3.5 insulation to plasterboard ceiling

-foil sarking underneath tiled roof

-R2.0 insulation to all ceilings with non trafficable roof

- -foil sisalation to all ground and first floor cavity brick external walls
- -Weather stripping to external doors & windows

-all awning windows shall be: Aluminium standard single-glazed: clear glass: U = 6.70 & SHGC = 0.57 -all other windows and sliding doors shall be: Aluminium standard single-glazed: clear glass: U = 6.70& SHGC = 0.70

-RWT: 2,500L to collect 80sqm of roof area and to be connected to laundry and landscape

-hot water system: 4star gas instantaneous or equivalent


-pool capcity: 26 Kl

0008833444 16 Aug 2023 Assessor Noura Al Hazzouri 5.4 Accreditation No. DMN/18/1891 HOUSE Address 98 Chaseling Street, Greenacre , NSW , 2190 南部省 hstar.com.a




			AMENDMENTS			FILE:	JOB N0: 2305644	PROJECT: TWO STOREY DWELLING WITH BASEMENT, SWIMMING POOL & FRONT FENCE
These designs, plans & specifications and the corpoperty of Dwell Designs Australia and may not or copied wholly or in part without the prior writte	povright therein are the	DATE	DESCRIPTION	ISSUE		DRAWN: CB		
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or copied wholly or in part without the prior writte	n consent of this office.	00.00.20	Dit Cobiniccion	^	DIVELL DESIGNS		DRAWING No:	
A C C R E D I T E D Construction. Contractors to verify all dimensions	aloog gigned for				AUSTRALIA	PLOT DATE: 9/08/2023	1/18	ADDRESS: 98 CHASELING STREET GREENACRE NSW
BUILDING DESIGNER construction. Figured dimensions to be taken in pscaled drawings.					Level 1, 28 Phillip St Parramatta NSW 2150 P.O Box 2294 North Parramatta NSW 1750 P.O Box 2294 North Parramatta NSW 1750 P.O Box 2294 North Parramatta NSW 1750	ACCREDITATION 6475	ISSUE A	TITLE: Cover Sheet

LOT 367, D.P. 11603, AREA = 605.50 m² 98 CHASELING ST GREENACRE, NSW 2190

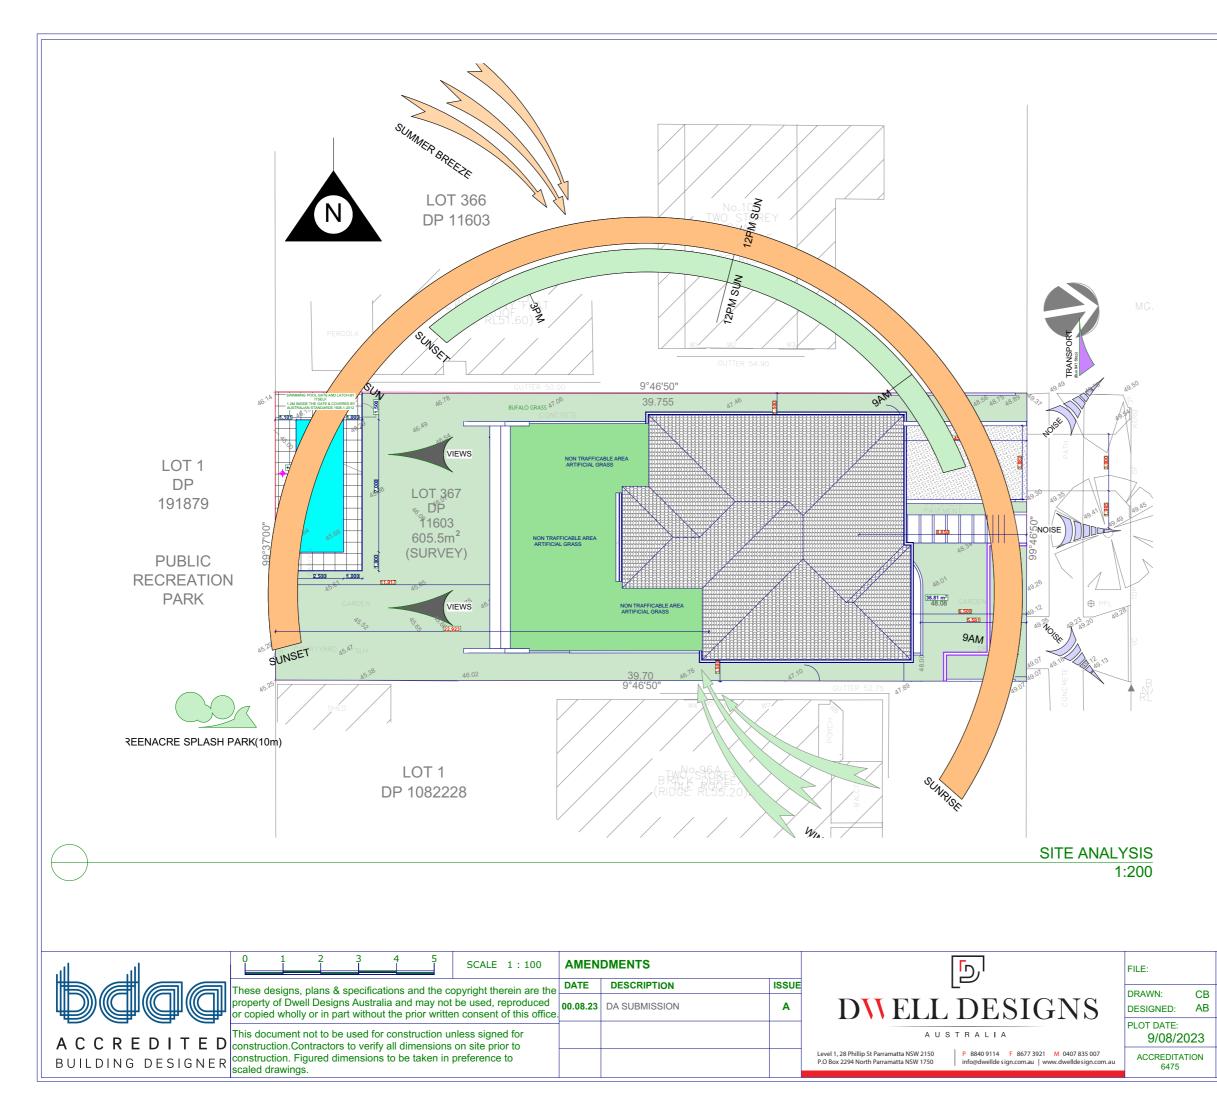



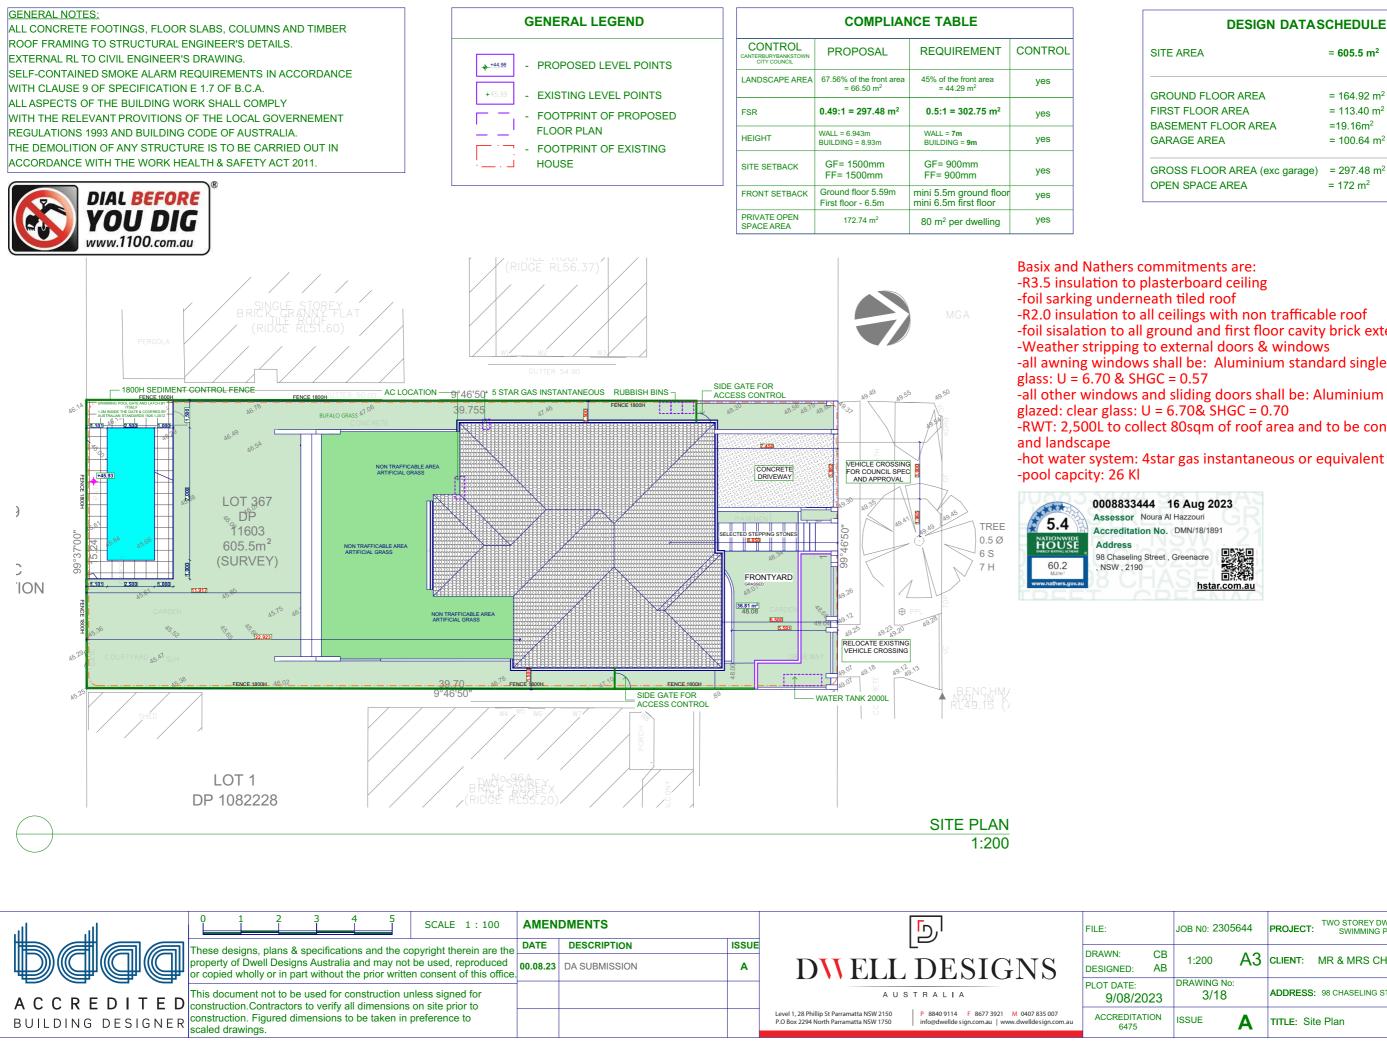

DESIGN DATASCHEDULE :

SITE AREA	= 605.5 m ²
GROUND FLOOR AREA	= 164.92 m ²
FIRST FLOOR AREA	= 113.40 m ²
BASEMENT FLOOR AREA	=19.16m ²
GARAGE AREA	= 100.64 m ²
	- 007 402


GROSS FLOOR AREA (exc garage) = 297.48 m^2 $= 172 \text{ m}^2$


-foil sisalation to all ground and first floor cavity brick external walls -all awning windows shall be: Aluminium standard single-glazed: clear -all other windows and sliding doors shall be: Aluminium standard single-


-RWT: 2,500L to collect 80sqm of roof area and to be connected to laundry




	JOB N0: 23056	644	PROJECT: TWO STOREY DWELLING WITH BASEMENT, SWIMMING POOL & FRONT FENCE
CB AB	1:200	A3	CLIENT: MR & MRS CHAHAYTA
23	DRAWING No: 3/18		ADDRESS: 98 CHASELING STREET GREENACRE NSW
ON	ISSUE	Α	TITLE: Site Plan

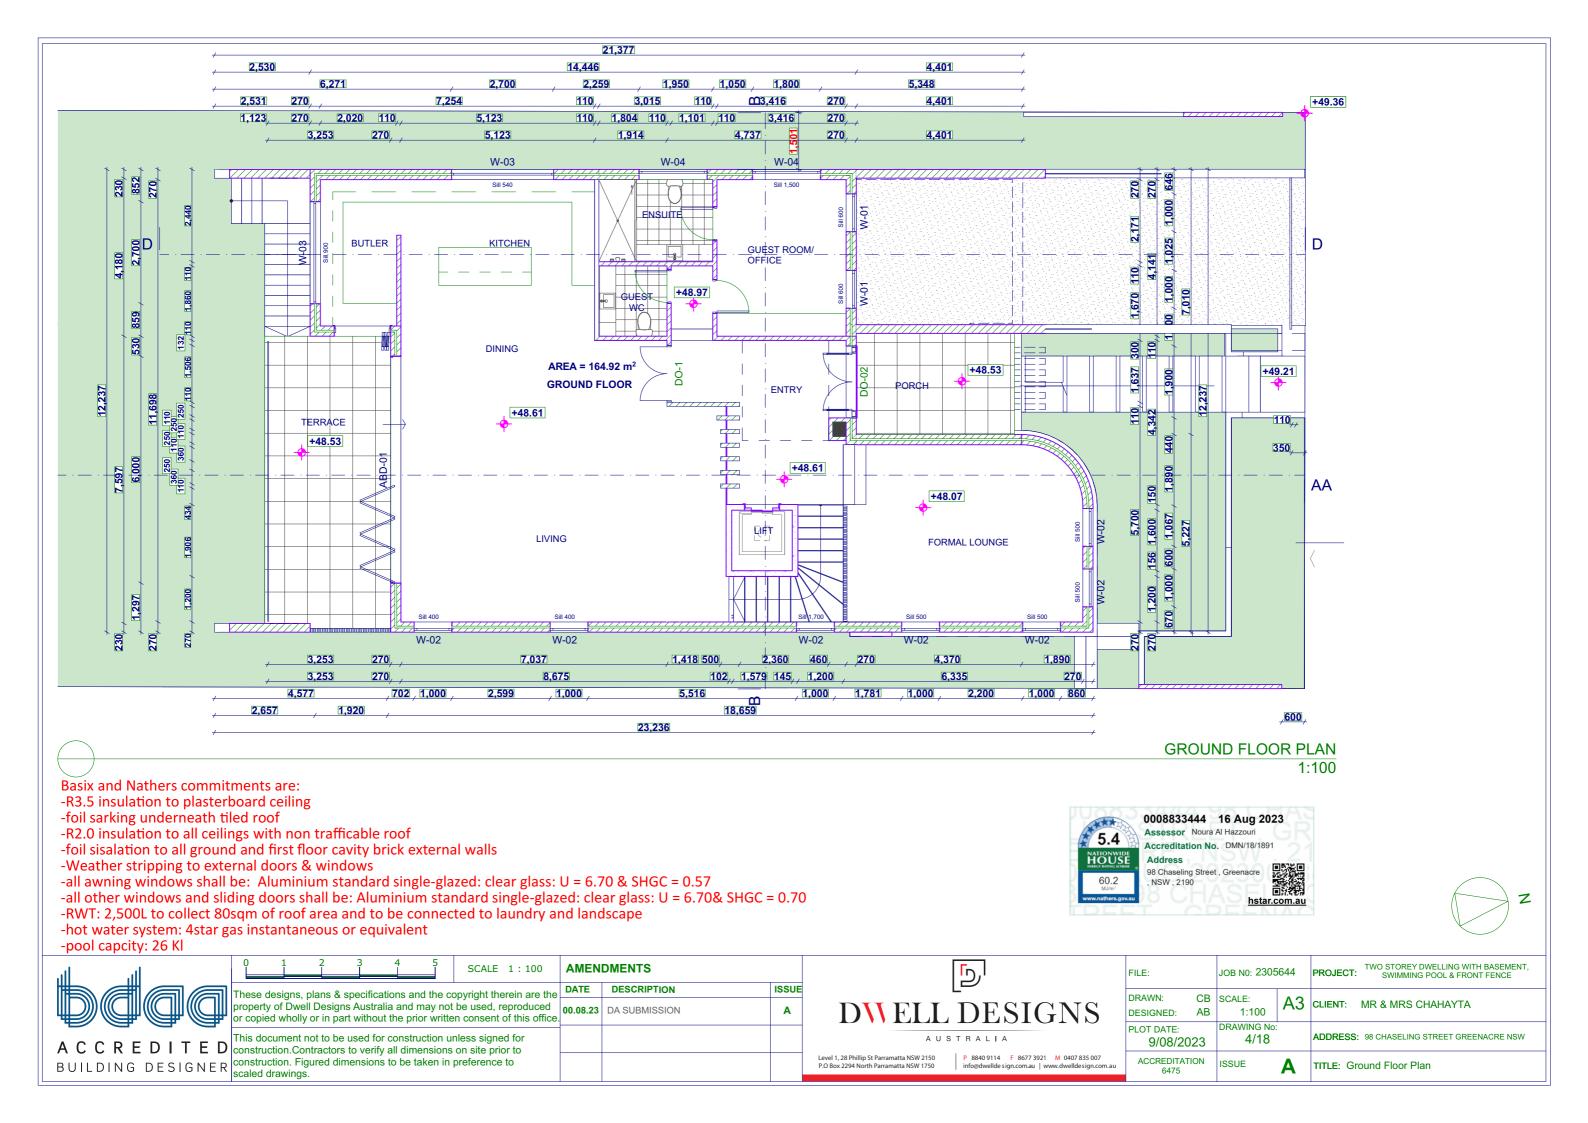


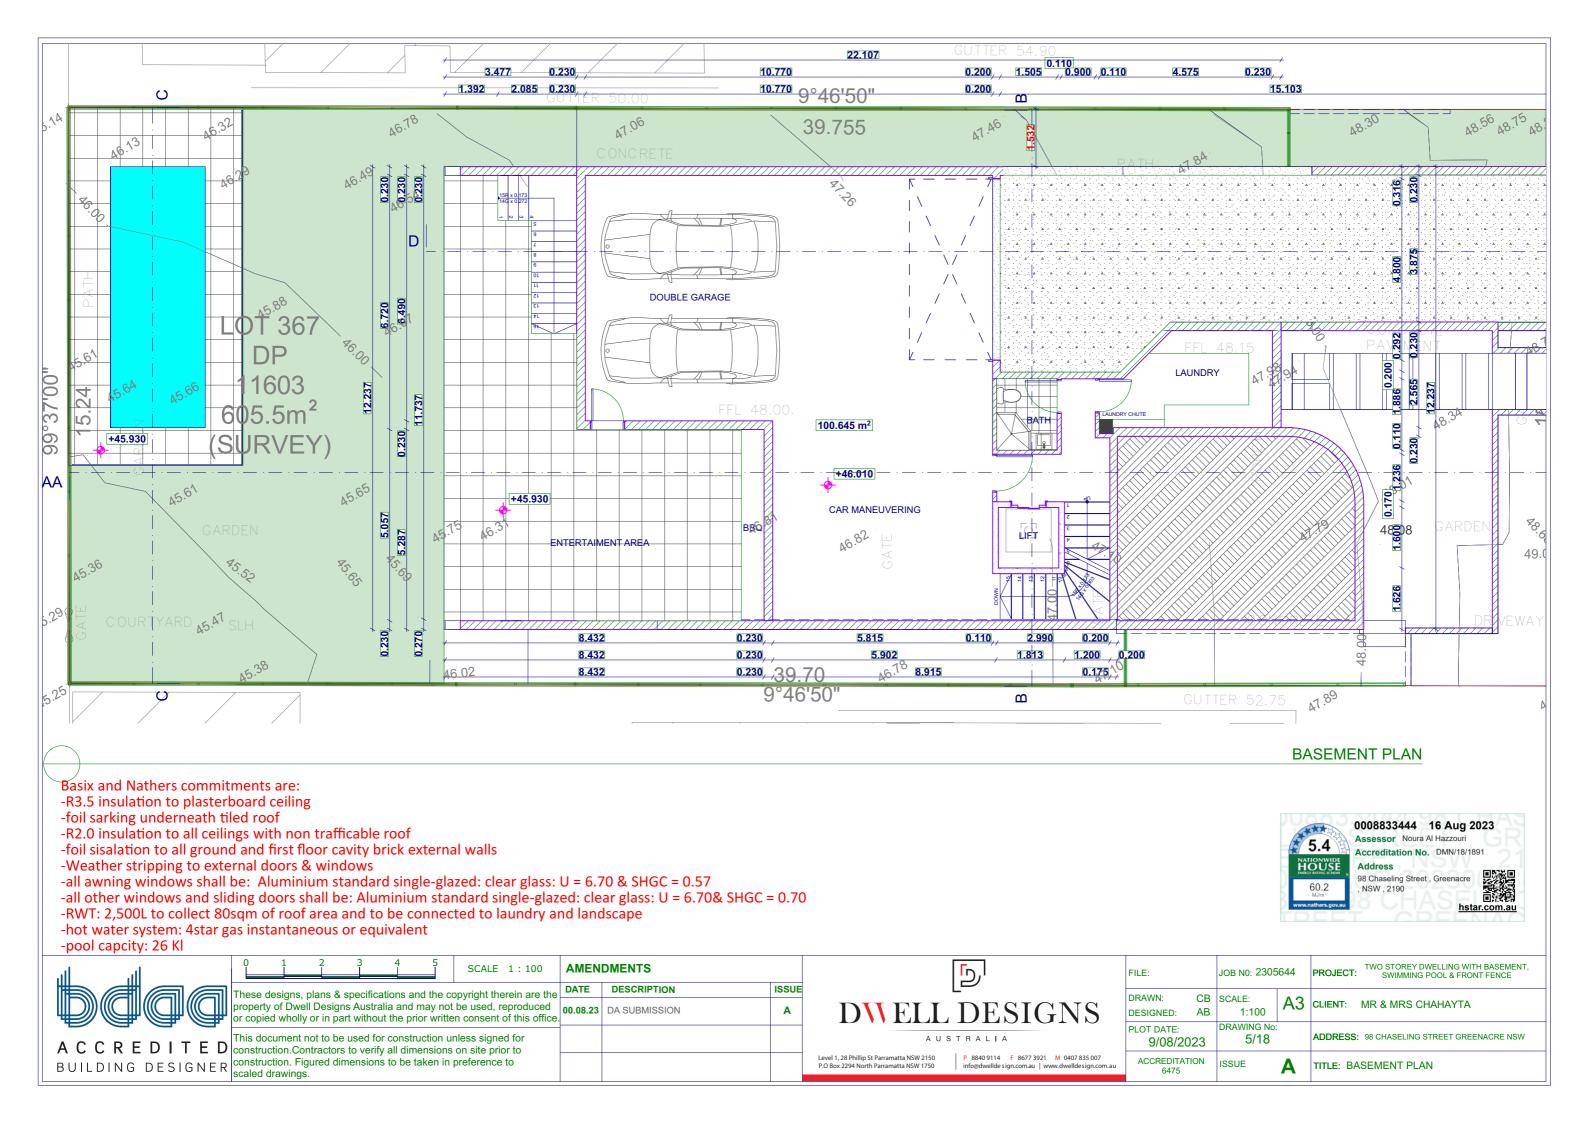

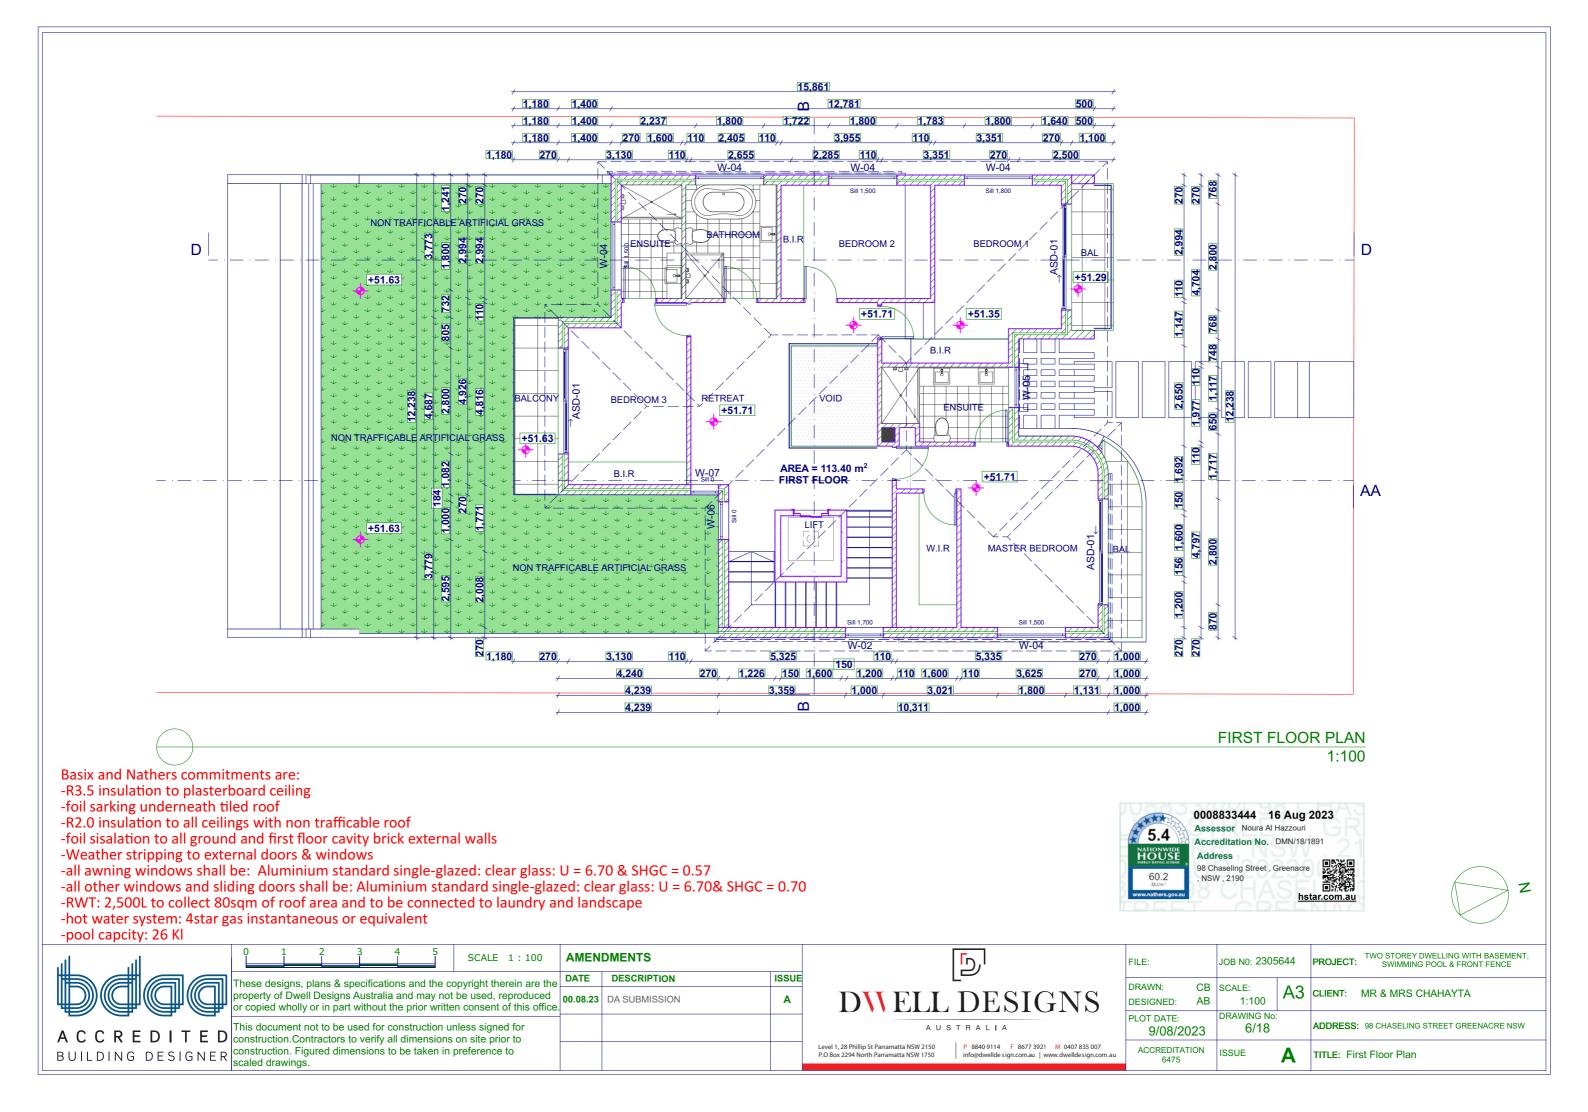




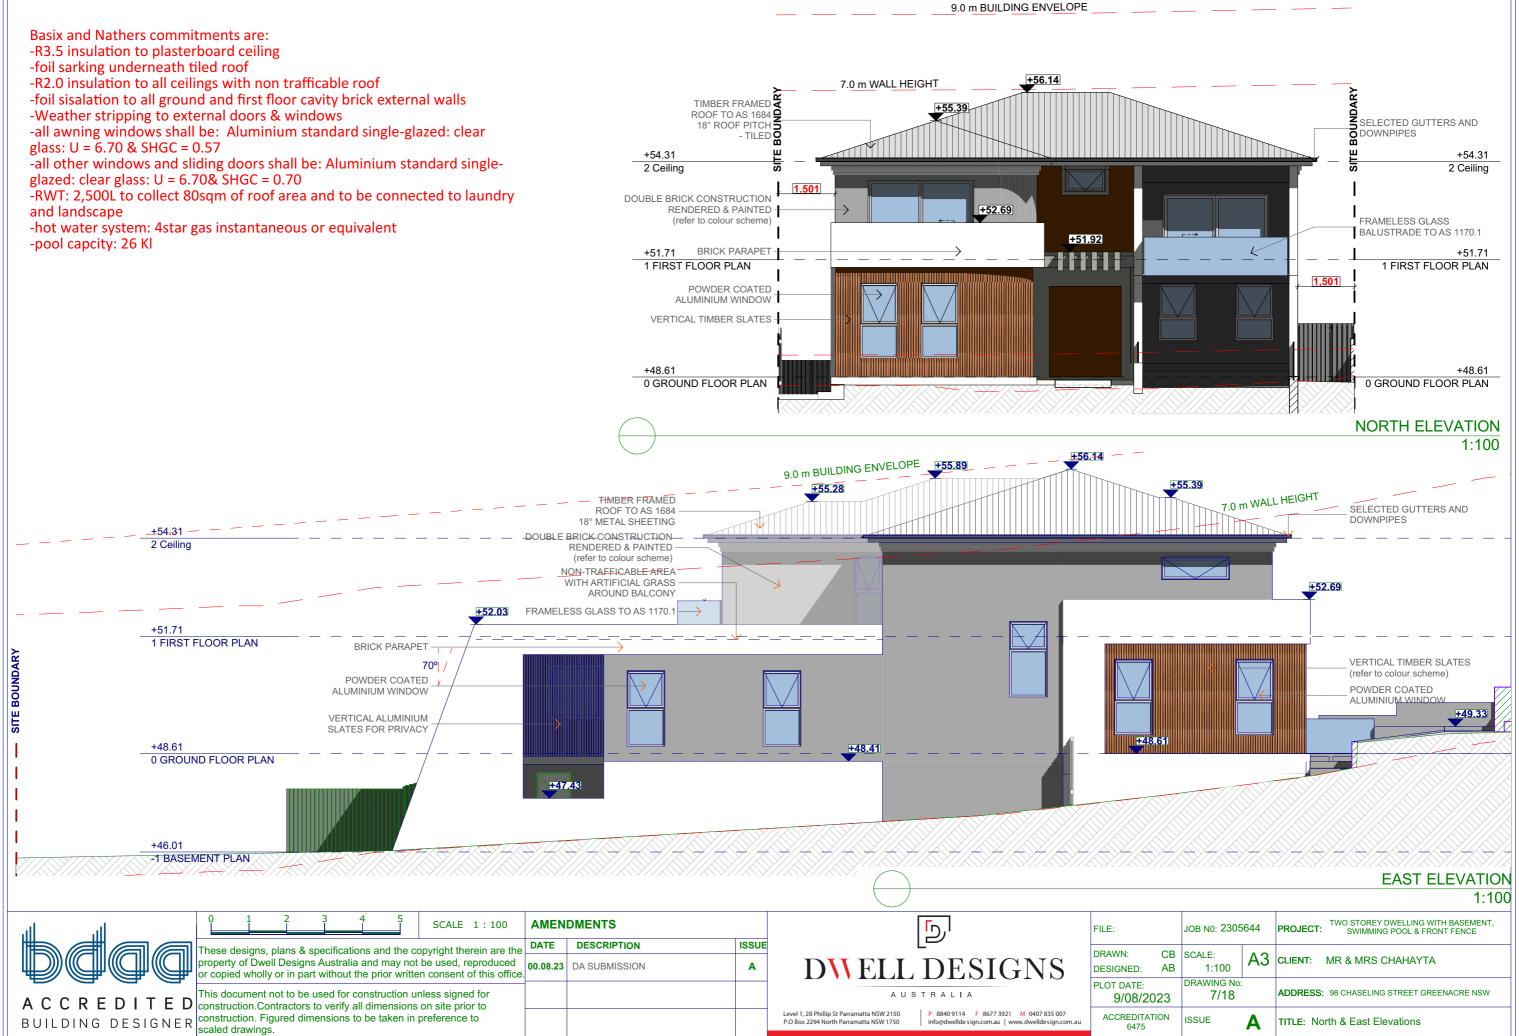

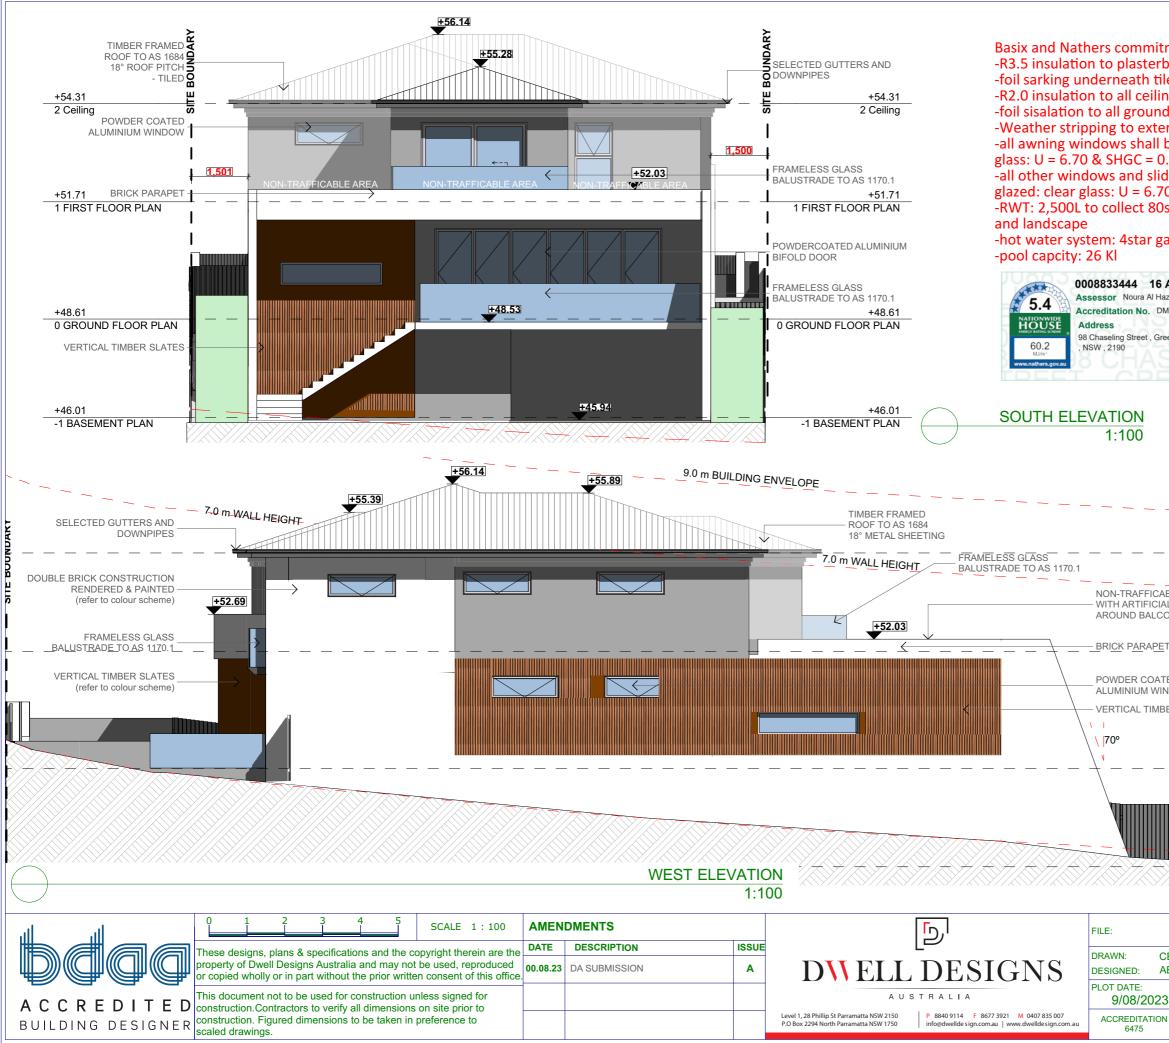

ernal doors & win be: Aluminium s).57 ding doors shall b	avity brick external walls
0& SHGC = 0.70 Sqm of roof area	and to be connected to laundry
as instantaneous	or equivalent
Aug 2023 azzouri MN/18/1891 reenacre	
	+54.31 2 Ceiling
ABLE AREA AL GRASS ONY	
ET TED NDOW BER SLATES	1 FIRST FLOOR PLAN
	+48.61 0 GROUND FLOOR PLAN
JOB N0: 2305644	PROJECT: TWO STOREY DWELLING WITH BASEMENT, SWIMMING POOL & FRONT FENCE
AB SCALE: A3	CLIENT: MR & MRS CHAHAYTA
3 BRAWING No: 3 8/18	ADDRESS: 98 CHASELING STREET GREENACRE NSW
N ISSUE A	TITLE: South & West Elevations

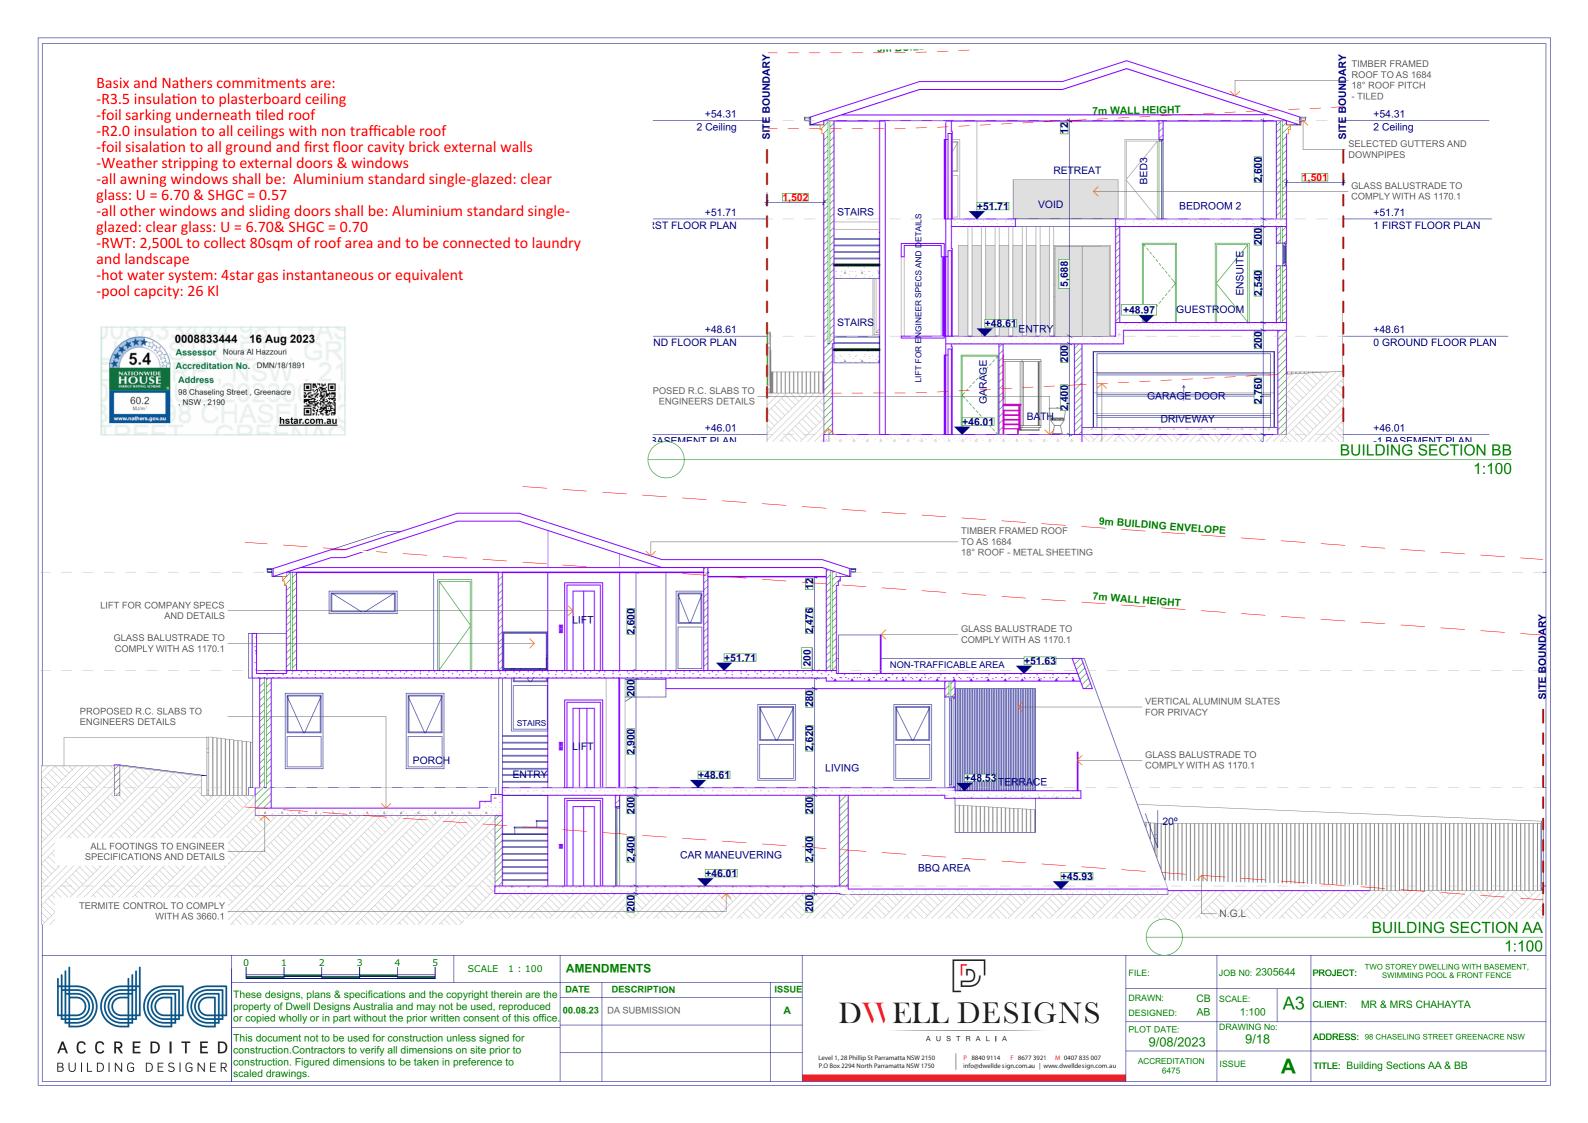

SPECIFICATIONS

SITE PREPARATION

Existing planted species in raised garden boxes to be selectively removed from site and/or replanted, and sculptured earths on site

specifications. Planted material to be stored in pots on site in order to be replanted where specified

Any existing trees and vegetation to be retained shall be preserved and protected from damage of any sort during the execution of landscape work. In particular, root systems of existing plants must not be disturbed. Any nearby site works should be carried out carefully using hand tools. Storage of materials, mixing of materials, vehicle parking, disposal of liquids, machinery repairs and refueling, site office and sheds, and the lighting of fires shall not occur within three (3) metres of any existing or new trees. Do not stockpile soil, rubble or other debris cleared from the site, or building materials within the drip line of existing or new trees. All vegetation not shown on plan to be removed. No tree removal is to occur without the presence of the Arborist.

SERVICES

Services and utilities shown have been located by physical evidence and/or by reference to surveys provided. Pits may not have been opened to verify the type of utility. Excavation has not been carried out to confirm underground location. Service details should be confirmed with the relevant service authority during design and prior to commencement of construction.

SOIL PREPARATION

Remove min 300mm of existing site soil where it does not interfere with the roots of the existing trees

Provide soil profiles as follows;

Planter box mix similar to that supplied by ANL to all garden beds as specified on the plan

Any imported soil or soil blends using site topsoil materials used in the top 600mm of any landscaped area finished soil profile shall meet the requirements of AS 4419 - 2003

'soils for landscaping and garden use'. Soils shall be placed and compacted in layers to prevent undue settlement. Sub-base filling and placement shall meet the engineers material and compaction requirements.

FROSION CONTROL

Where gradients in finished surface level exceed 1:2.5 mulch is to be held in place with an unobtrusive biodegradable fit for purpose netting with the netting to be fixed in place as the manufacturers specification for this particular situation.

STAKING

All trees not self supporting and trees generally shall be provided with pointed hardwood stakes as follows:

Trees up to container size of 25L - 2 x 25mm x 25mm x 1.8m high stakes at each

Trees above container size of 25L - 2 x 50 x 50 x 2.1 high stakes each

ties shall be of 50mm wide jute mesh webbing tied ' figure eight pattern' to support the plant and ties to be fixed securely to stakes PLANT SPECIFIC INFORMATION

Placing of proposed plants to be done with the coordination of the landscape architect. All plants to be placed in position prior to planting.

SOIL IMPROVEMENT

Where site topsoil is to be used it shall be improved by adding Botany humas or similar at a ratio of 1:3 by volume. PLANTING MATERIALS

Plants shall correspond to the planting index. There shall be no substitution in quality or quantity of material unless otherwise specified by the landscape architect. The landscape architec reserves the right to refuse any material showing signs of disease, distorted growth habit or malpractice. Plants to be placed in the ground no more than 48 hours after arrival on site. Plants to be planted in accordance with the planting detail. Planting holes to be dug double the width of the pot size and backfilled with organic soil and native fertilizer. The finished level of the plant is to finish flush with the existing pot level. No backfilling around the stem of the plant with either soil or mulch EDGING

brick or paver mowing edge layed on 4:1 mortar mix with bricktor .

TURF

use premium sir walter turf over 250mm ripped subgrade with minimum of 50mm turf underlay. MULCH

All planter beds and garden areas shall have a minimum depth of 80mm FINE playground mulch . All mulch is to be free of deleterious matter such as soil, weeds and sticks.

FERTILISER

On completion of work all planting areas are to be fertilised with organic life, slow release fertiliser (Osmocote 8-9 month) which is to be sufficiently watered in, as well as a soluble fertiliser similar to Seasol applied in accordance with the manufacturers details. Do not use pellet fertilizer with odour on the job

HARD CONSTRUCTION

REFER TO ARCHITECTURAL PLANS AND SPECIFICATION FOR PAVING AND HARDSCAPED DETAILS


All civil, structural and hydraulic work associated with this project shall be to consulting Engineer's details. All external stairs to be constructed in accordance with Clause

D2.13 of the Building Code of Australia.


IRRIGATION


supply and install drip irrigation system from water tank to all garden beds. Run min. 40mm pipe under all hard surfaces for future access. NOTES:

ALL GARDEN EDGING TO BE 75MM STEEL E.G. FORMBOSS EDGE SYSTEMS EUCY MULCH TO BE SPREAD IN ALL GARDEN BEDS @ 30-50MM DEPTH (NO MULCH TO BE USED WHERE THERE IS DICHONDRA.) PEBLES TO BE BLACK - 30-60MM DRAINAGE CELL COVERED BY GEO-FABRIC IN THE BASE OF ALL PLANTER BOXES. USE FREF DRAINING GARDEN MIXES

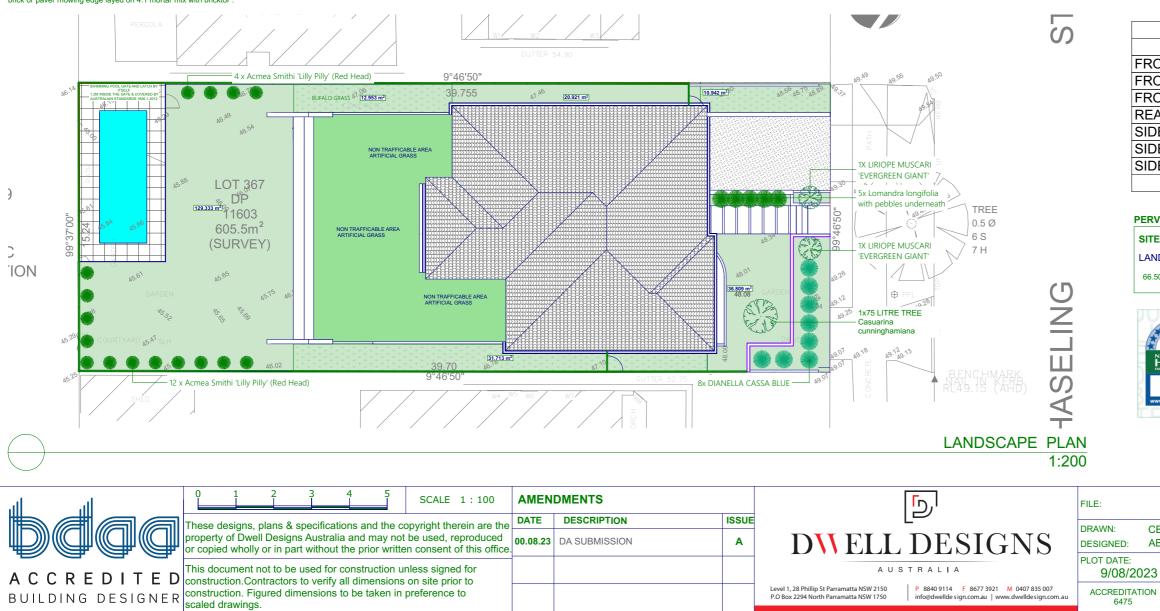



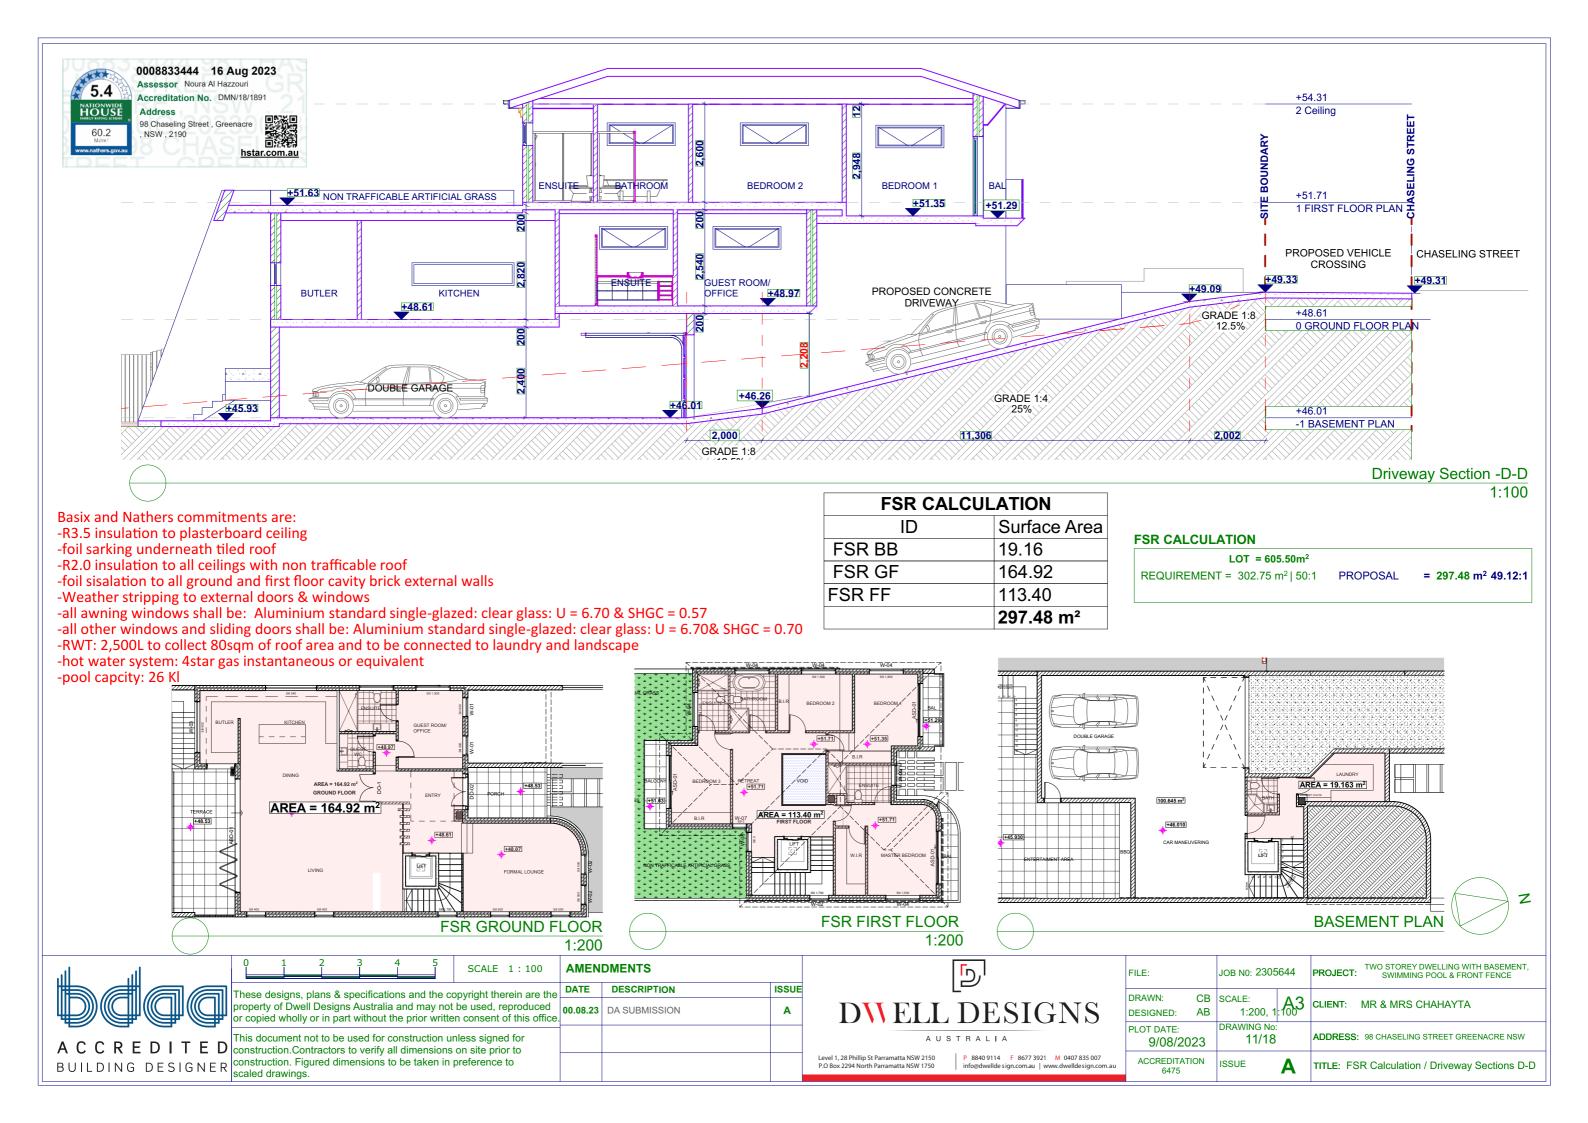

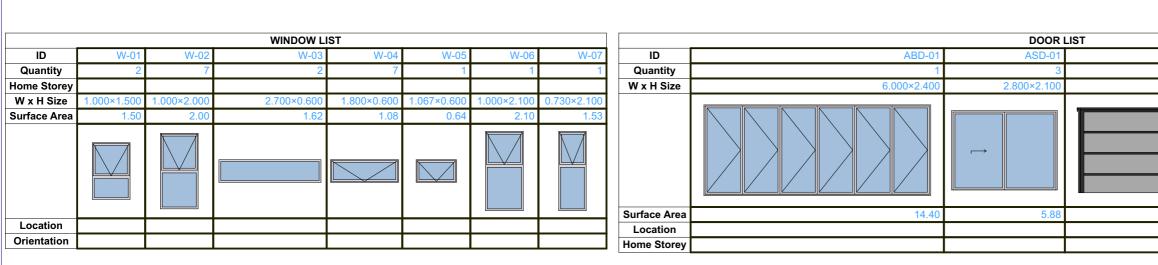

BASIX REQUIREMENTS

Basix and Nathers commitments are:

-R3.5 insulation to plasterboard ceiling

-foil sarking underneath tiled roof

-R2.0 insulation to all ceilings with non trafficable roof

-foil sisalation to all ground and first floor cavity brick external walls

-Weather stripping to external doors & windows


-all awning windows shall be: Aluminium standard single-glazed: clear glass: U = 6.70 & SHGC = 0.57 -all other windows and sliding doors shall be: Aluminium standard single-glazed: clear glass: U = 6.70& SHGC = 0.70


-RWT: 2,500L to collect 80sqm of roof area and to be connected to laundry and landscape -hot water system: 4star gas instantaneous or equivalent -pool capcity: 26 Kl

0 1 2 3 4 5 SCALE 1:100		DMENTS			FILE:	JOB N0: 230)5644	PROJECT: TWO STOREY DWELLING WITH BASEMENT, SWIMMING POOL & FRONT FENCE
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BUILDING DESIGNER scaled drawings.				Level 1, 28 Phillip St Parramatta NSW 2150 P.O Box 2294 North Parramatta NSW 1750 P.O Box 2294 North Parramatta NSW 1750 P.O Box 2294 North Parramatta NSW 1750	ACCREDITATION 6475	ISSUE	Α	TITLE: Doors and Windows List & Basix Requirements

D-03	DO-1	DO-02	FOLD-01
4.800×2.200	ı 1.500×2.400	ı 1.900×2.400	1.493×1.500
10.56	3.60	4.56	2.24



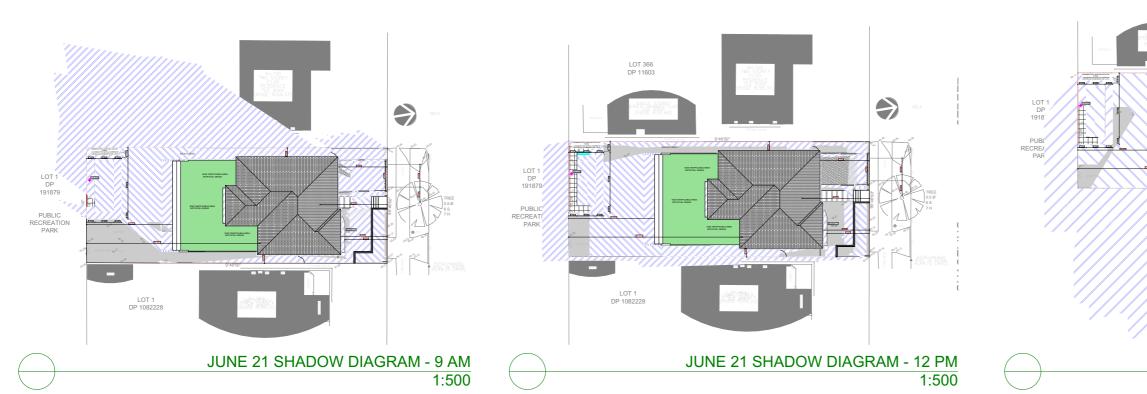

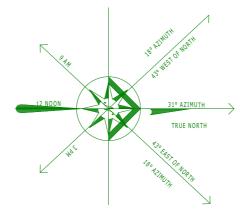

SUN SHADOW DIAGRAM PREPARED FOR 9 AM, 12 NOON & 3 PM MID-WINTER, JUNE 21.



0008833444 16 Aug 2023

Accreditation No. DMN/18/1891

98 Chaseling Street, Greenacre

hstar.com.au

Assessor Noura Al Hazzouri

Address


NSW , 2190

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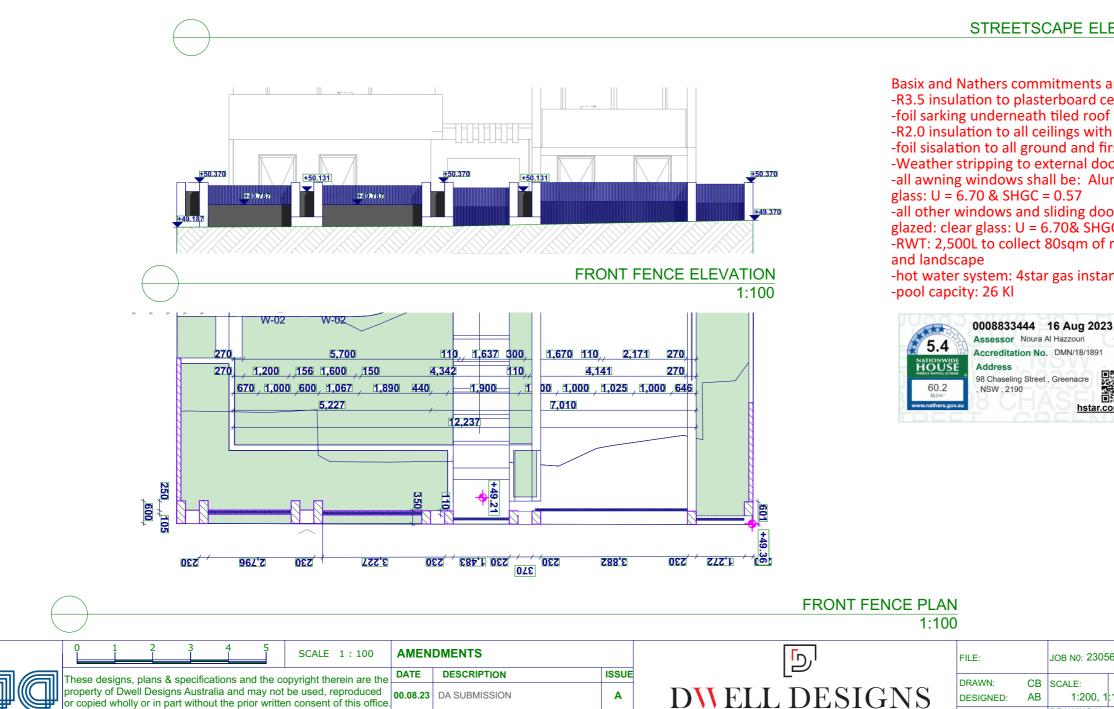
5.4

HOUSE

60.2



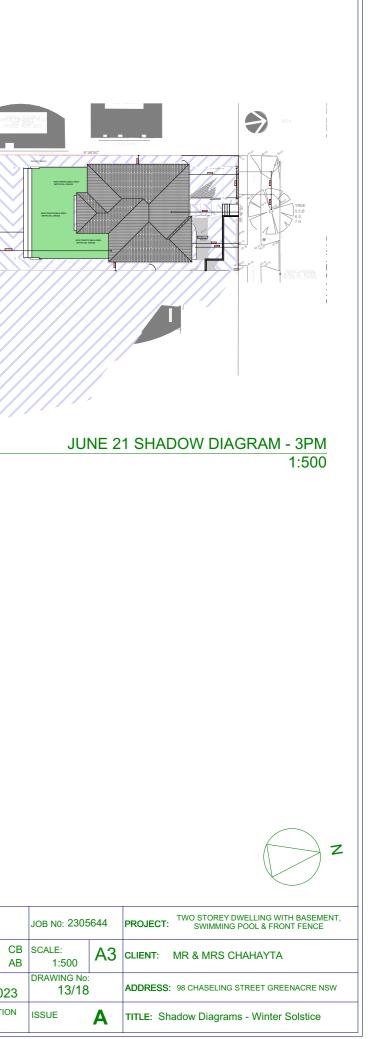



Α

AUSTRALIA

P 8840 9114 F 8677 3921 M 0407 835 007

info@dwelldesign.com.au | www.dwelldesign.com

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glass: U = 6.70 & SHGC = 0.57 -pool capcity: 26 Kl

DESIGNED:

PLOT DATE:

STREETSCAPE ELEVATION 1:200

Basix and Nathers commitments are:


- -R3.5 insulation to plasterboard ceiling
- -R2.0 insulation to all ceilings with non trafficable roof
- -foil sisalation to all ground and first floor cavity brick external walls
- -Weather stripping to external doors & windows
- -all awning windows shall be: Aluminium standard single-glazed: clear
- -all other windows and sliding doors shall be: Aluminium standard singleglazed: clear glass: U = 6.70& SHGC = 0.70
- -RWT: 2,500L to collect 80sqm of roof area and to be connected to laundry


-hot water system: 4star gas instantaneous or equivalent





ILE:	JOB N0: 2305644	PROJECT: TWO STOREY DWELLING WITH BASEMENT, SWIMMING POOL & FRONT FENCE
DRAWN: CB DESIGNED: AB	SCALE: 1:200, 1:100	CLIENT: MR & MRS CHAHAYTA
PLOT DATE: 9/08/2023	DRAWING No: 14/18	ADDRESS: 98 CHASELING STREET GREENACRE NSW
ACCREDITATION 6475	ISSUE A	TITLE: Front Fence / Streetscape

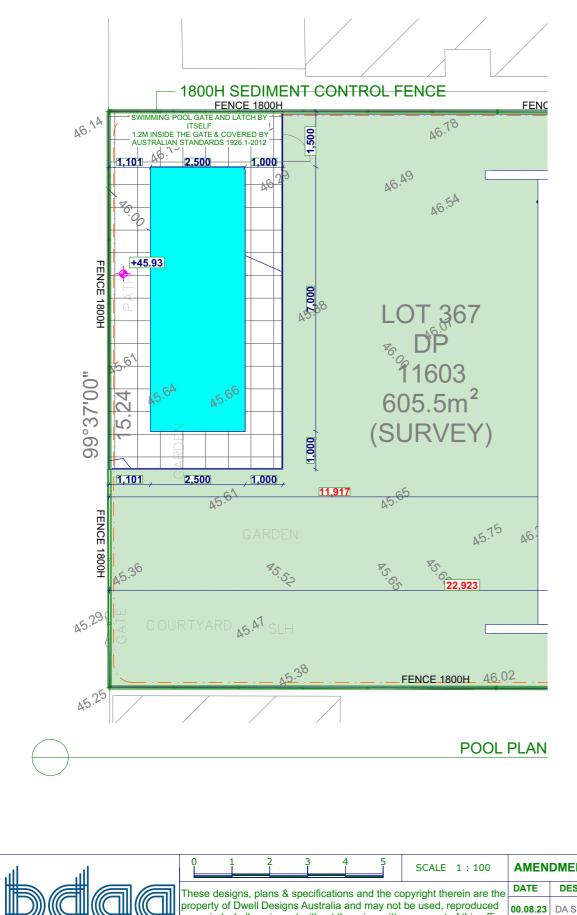

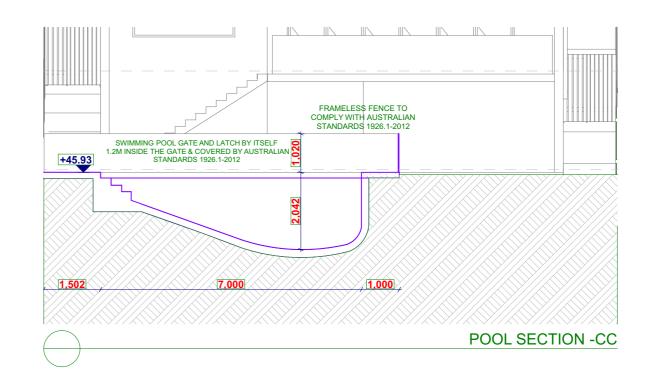

Basix and Nathers commitments are:

- -R3.5 insulation to plasterboard ceiling
- -foil sarking underneath tiled roof
- -R2.0 insulation to all ceilings with non trafficable roof
- -foil sisalation to all ground and first floor cavity brick external walls
- -Weather stripping to external doors & windows
- glass: U = 6.70 & SHGC = 0.57

-all other windows and sliding doors shall be: Aluminium standard singleglazed: clear glass: U = 6.70& SHGC = 0.70 -RWT: 2,500L to collect 80sqm of roof area and to be connected to laundry

and landscape


-hot water system: 4star gas instantaneous or equivalent -pool capcity: 26 Kl



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-all awning windows shall be: Aluminium standard single-glazed: clear



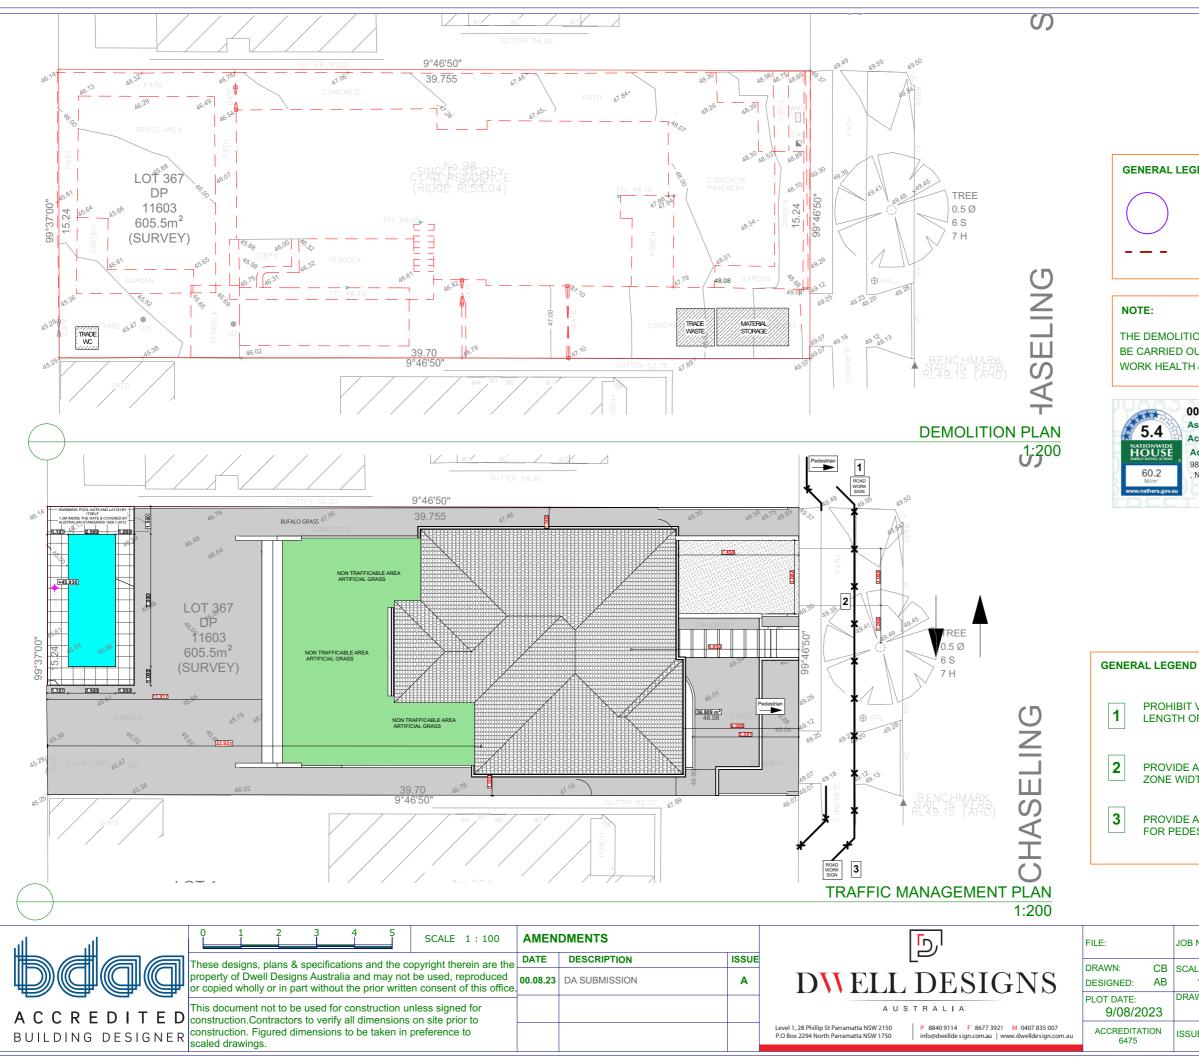

GENERAL LEGEND



ALL TREES SHOWN LINE TO REMAIN

ALL ELEMENTS SHOWN DASHED TO BE REMOVED

THE DEMOLITION OF ANY STRUCTURE IS TO BE CARRIED OUT IN ACCORDANCE WITH THE WORK HEALTH & SAFETY ACT 2011.



0008833444 16 Aug 2023 Assessor Noura Al Hazzouri Accreditation No. DMN/18/1891 Address 98 Chaseling Street , Greenacre NSW, 2190

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PROHIBIT VEHICLES STOPPING ALONG THE LENGTH OF THE NARROWED CARRIAGE WAY

PROVIDE A MINIMUM TRAFFIC ZONE WIDTH OF 3.5M

PROVIDE A MINIMUM CLEAR WIDTH OF 1.5M FOR PEDESTRIAN ACCESS



	JOB N0: 2305	644	PROJECT: TWO STOREY DWELLING WITH BASEMENT, SWIMMING POOL & FRONT FENCE
CB AB	SCALE: 1:200	A3	CLIENT: MR & MRS CHAHAYTA
23	DRAWING No: 16/18		ADDRESS: 98 CHASELING STREET GREENACRE NSW
N	ISSUE	Α	TITLE: Demolition Plan/ Traffic Management Plan

ENVIRONMENTAL SITE MANAGEMENT NOTES

EROSION AND SEDIMENT CONTROLS:


- 1. ALL EXISTING TREES TO BE RETAINED UNLESS SHOWN OTHERWISE ON APPROVED ARCHITECT'S OR ARBORIST REPORT. TREES RETAINED ARE TO BE PROTECTED WITH A HIGH VISIBILITY FENCE, PLUS TO INDIVIDUAL TREES AS NECESSARY.
- 2. RETAIN ALL EXISTING PLANT COVER WHEREVER POSSIBLE.
- 3. SEDIMENT AND EROSION CONTROLS MUST BE IN PLACE PRIOR TO THE COMMENCEMENT OF ANY EARTHWORKS OF DEMOLITION ACTIVITY.
- 4. INSTALL TEMPORARY SEDIMENT BARRIERS TO ALL INLET PITS LIKELY TO COLLECT SILT LADEN WATER, UNTIL SURROUNDING AREAS ARE PAVED OR REGRASSED
- 5. ALL SILT FENCES AND BARRIERS ARE TO BE MAINTAINED IN GOOD ORDER AND REGULARLY DESILTED DURING THE CONSTRUCTION PERIOD.
- 6. IT IS THE RESPONSIBILITY OF THE CONTRACTOR TO ENSURE THAT ALL MEASURES ARE TAKEN DURING THE COURSE OF CONSTRUCTION TO PREVENT SEDIMENT EROSION & POLLUTION OF THE SUPERVISING ENGINEER SHOULD BE CONTACTED IF IN DOUBT.
- 7. WASTE MATERIALS ARE TO BE STOCKPILED OR LOADED INTO SKIP BINS LOCATED AS SHOWN ON PLAN.
- 8. STOCKPILES OF LOOSE MATERIALS SUCH AS SAND, SOIL, GRAVEL MUST BE COVERED WITH GEOTEXTILE SILT FENCE MATERIAL. PLASTIC SHEETING OR MEMBRANE MUST NOT BE USED. SAFETY BARRICADING SHOULD BE USED TO ISOLATE STOCKPILES OF SOLID MATERIALS SUCH AS STEEL REINFORCING, FORMWORK, SCAFFOLDING,
- 9. ALL VEHICLES LEAVING THE SITE MUST PASS OVER THE 'BALLAST' AREA TO SHAKE OFF SITE CLAY AND SOIL. IF NECESSARY WHEELS AND AXLES ARE TO BE HOSED DOWN. BALLAST IS TO BE MAINTAINED AND REPLACED AS NECESSARY DURING THE CONSTRUCTION PERIOD.
- 10. TRUCKS REMOVING EXCAVATED MATERIAL SHOULD TRAVEL ON STABILISED CONSTRUCTION PATHSAND MATERIAL SHOULD BE TAKEN TO THE TRUCK TO REDUCE TRUCK MOVEMENT ON THE SITE. TRUCKS TO BE LIMITED TO SINGLE UNIT HEAVY RIGID VEHICLES. (NO SEMI-TRAILERS)
- 11. ANY SEDIMENT DEPOSITED ON THE PUBLIC WAY, INCLUDING FOOTPATH RESERVE AND ROAD SURFACE. IS TO BE REMOVED IMMEDIATELY.
- 12. PROVIDE BARRIERS AROUND ALL CONSTRUCTION WORKS WITHIN THE FOOTPATH AREA TO PROVIDE SAFE ACCESS FOR PEDESTRIANS.
- 13. CONCRETE PUMPS AND CRANES ARE TO OPERATE FROM WITHIN THE BALLAST ENTRY DRIVEWAY AREA AND ARE NOT TO OPERATE FROM THE PUBLIC ROADWAY UNLESS SPECIFIC COUNCIL PERMISSION IS OBTAINED.
- 14. DELIVERY VEHICLES MUST NOT STAND WITHIN THE PUBLIC ROADWAY FOR MORE THAN 20 MINUTES AT A TIME.
- 15. ANY EXCAVATION WORK ADJACENT TO ADJOINING PROPERTIES OR THE PUBLIC ROADWAY IS NOT TO BE COMMENCED UNTIL THE STRUCTURAL ENGINEER IS CONSULTED AND SPECIFIC INSTRUCTIONS RECEIVED FROM THE ENGINEER.
- 16. TOILET FACILITIES MUST BE EITHER A FLUSHING TYPE OR APPROVED PORTABLE CHEMICAL CLOSET. CHEMICAL AND SERVICED ON A REGULAR BASIS SO THAT OFFENSIVE ODOUR

IS NOT EMITTED.


Min length 3m AND AND A Min width 3m Contoxti fabric 50-75m Existing roadway Runoff from pad directed to sediment trap TEMPORARY CONSTRUCTION EXIT Filter aggregate-SILT FENCE BARRIER DETAIL SILT FENCE BARRIER EARTH BANK TO PREVENT SCOUR OF STOCKPILE SANDBAG IN GUTTER

Berm (0.3m min. high)

SANDBAG KERB SEDIMENT TRAP NTS

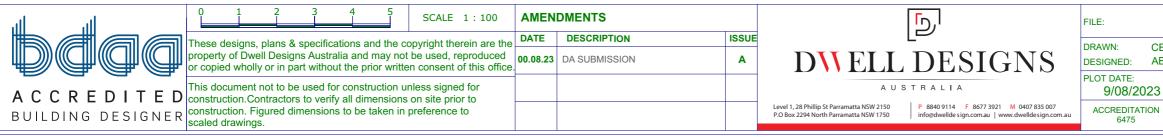

Construction site

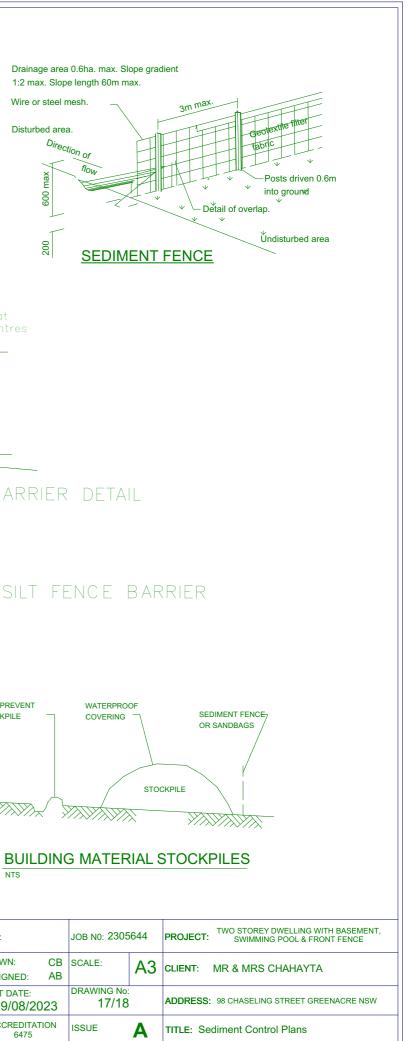













0 1 2 3 4 5 SCALE 1:100	AMEN	DMENTS	ந	FILE:	JOB N0: 2305644	PROJECT: TWO STOREY DWELLING WITH BASEMENT, SWIMMING POOL & FRONT FENCE
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